## 142 LAMBETH STREET, PANANIA PROPOSED BOARDING HOUSE DEVELOPMENT **STORMWATER CONCEPT PLANS**



						Nuovo Design Studio	Council Ranks
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Α	ISSUE FOR DEVELOPMENT APPLICATION	01/12/2022	KTS	EH	OC	P: po box 5210 chullora postshop chullora	
Issue	Description	Date	Designed	Engineer	Checked	E: İnfo@nuovodesignstuˈdio.com.au W: www.nuovodesignstudio.com.au	Mr. S.
·10	1cm at full size				20cm	ž	

LOCALITY PLAN N.T.S

DRAWING INDEX
DESCRIPTION
COVER SHEET PLAN
STORMWATER CONCEPT PLAN GROUND LEVEL
ON-SITE DETENTION DETAILS AND CALCULATION SHEET
SEDIMENT & EROSION CONTROL PLAN & DETAILS

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CIVIL & STORMWATER ENGINEERING SERVICES PTY LTD ABN: 27 644 422 506 Shop 1, 143-147 Parramatta Road, Concord, NSW P:(02) 8397 6500



IOT FOR CONSTRUCTION	

DSED BOARDING HOUSE DEVELOPMENT	Drawing Title COVER	SHEET PLAN
IWATER CONCEPT PLAN	Scale A1	Project No.
LOPMENT APPLICATION	N.T.S.	220601

Dwg. No. **000** 

Α



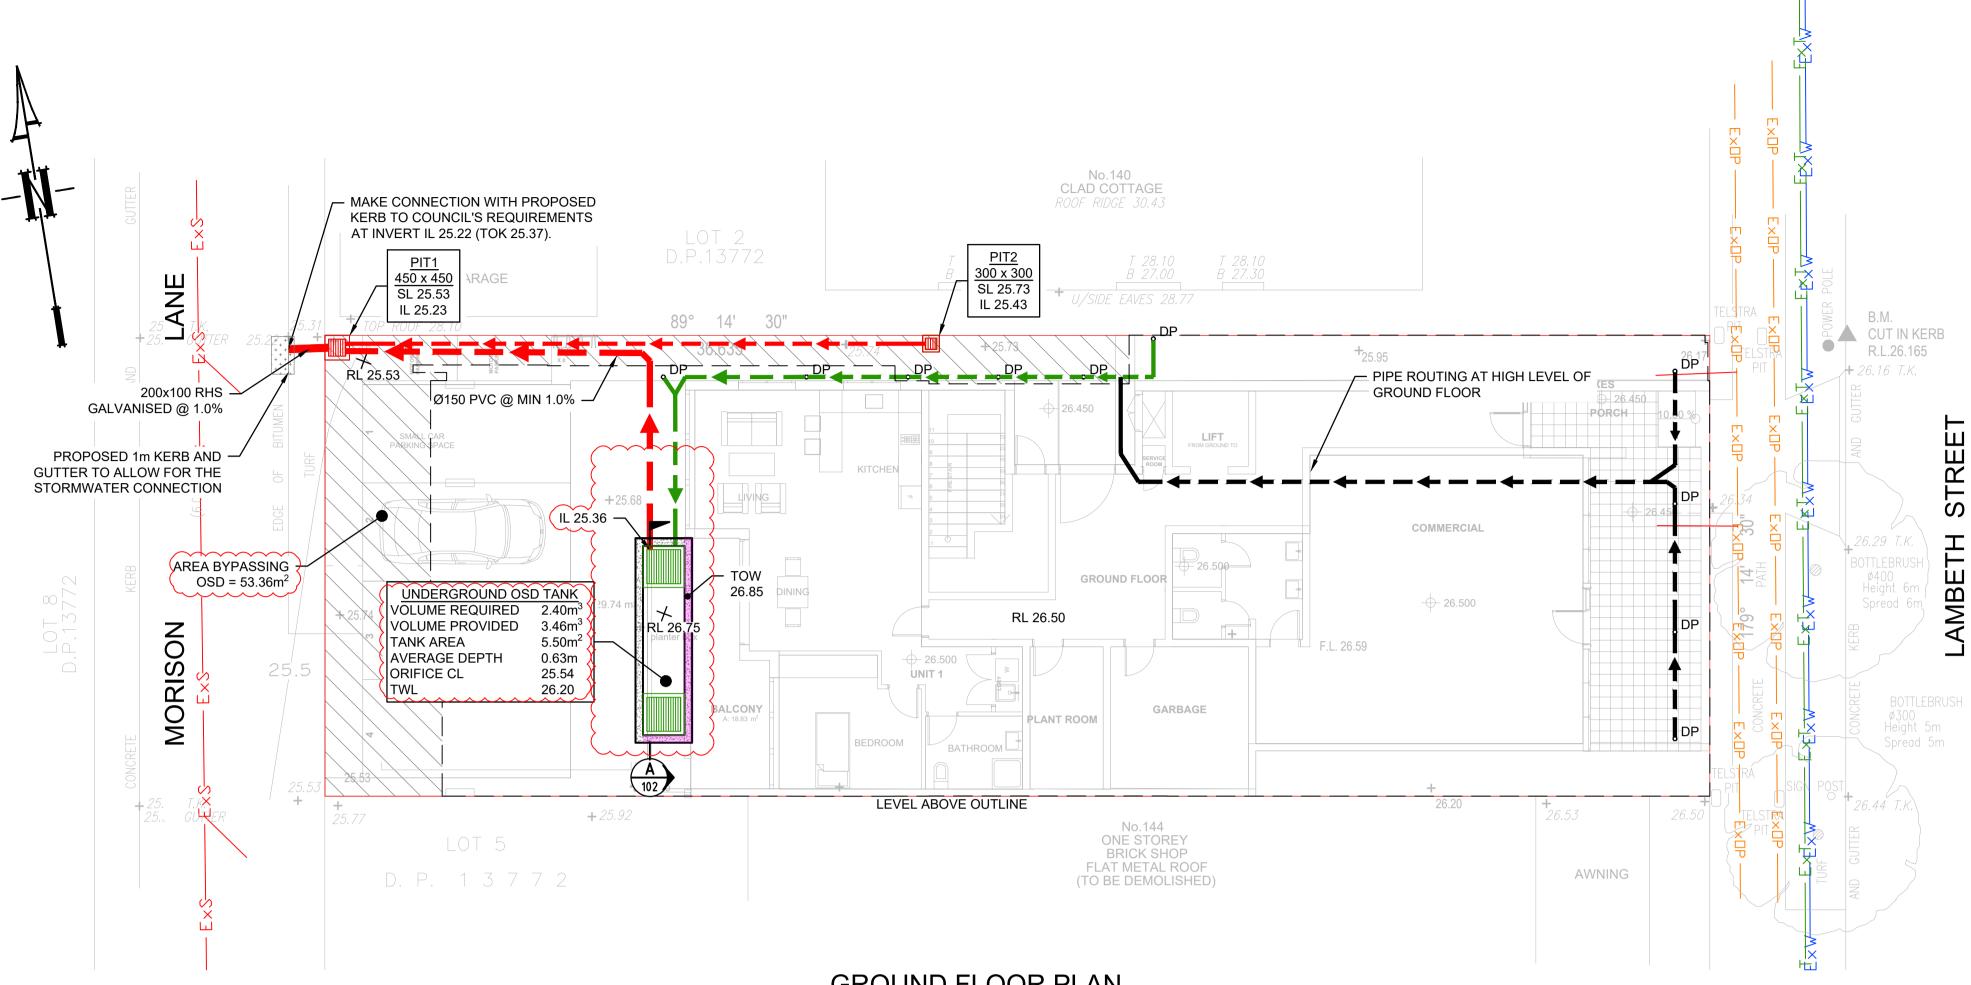
<b>— – → –</b>	PROPOSED STORMWATER DRAINAGE PIPE
→	PROPOSED STORMWATER DRAINING TO OSD
→	PROPOSED STORMWATER BYPASSING OSD
	Ø100 HDPE OR PVC WRAPPED IN 20mm ABLEFLEX STORMWATER DRAINAGE PIPE CAST IN SLAB
65	Ø65 HDPE OR PVC WRAPPED IN 20mm ABLEFLEX STORMWATER DRAINAGE PIPE CAST IN SLAB
50	Ø50mm HDPE OR PVC WRAPPED IN 20mm ABLEFLEX CAST IN SLAB
RWT	PROPOSED STORMWATER PIPE TO RAINWATER TANK
ss	Ø100mm SUBSOIL DRAINAGE TO BE WRAPPED IN GEOTEXTILE BIDIMA34
	RISER PIPE
O <sup>CE</sup>	Ø300 CLEANING EYE
RWT	RAINWATER TANK
o <sup>DP</sup>	DOWNPIPE Ø100
o <sup>VD</sup>	VERTICAL DROP Ø100
<b>®</b> PG	PLANTER GRATE Ø150
FG	FLOOR GRATE Ø150
E FG	FLOOR GRATE 200x200 (ALLOW MINIMUM 1.0% FALL TO FG)
D FW	FLOOR GRATE 300x300 (ALLOW MINIMUM 1.0% FALL TO FW)
🛈 RWO	RAINWATER OUTLET Ø260 SPS (ALLOW MINIMUM 1.0% FALL TO RWO)
👿 SPB	SUSPENDED PLANTER BOX RAINWATER OUTLET
× RL 47.00	DESIGN SURFACE LEVEL
NS 26.45 t	EXISTING SURFACE LEVEL
IL 47.00	INVERT LEVEL
O td	AC CONDENSER TUNDISH TO MANUFACTURER'S DETAILS
OF	Ø50mm EMERGENCY OVERFLOW SPITTERS/PIPES
δ	EXISTING STORMWATER
——— E×W———	EXISTING WATER MAIN
——— ExS———	EXISTING SEWER MAIN
——— ExT———	EXISTING TELSTRA
——— ExE———	EXISTING ELECTRICAL
——— ExG———	EXISTING GAS
ExOP	EXISTING OPTIC FIBER

NOTE		NC	)T	E
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FIRE COLLARS TO BE APPROVED BY THE CONTRACTOR AND IN ACCORDANCE TO THE FIRE RATING REPORT OF THE FIRE ENGINEER.

NOTE:

ALL REDUNDANT PIPELINES WITHIN FOOTPATH AREA MUST BE REMOVED AND FOOTPATH/KERB REINSTATED.



	<ul> <li><b>GENERAL NOTES</b></li> <li>1. ALL LINES ARE TO BE Ø90 uPVC 1.0% GRADE UNLESS NOTED OTHERWISE. CHARGED LINES TO BE SEWERGRADE &amp; SEALED.</li> <li>2. EXISTING SERVICES LOCATIONS SHOWN INDICATIVE ONLY. IT IS THE CONTRACTOR'S RESPONSIBILITY TO LOCATE &amp; LEVEL ALL EXISTING SERVICES PRIOR TO THE COMMENCEMENT OF ANY EARTHWORKS.</li> <li>3. ALL PIPES TO HAVE MIN 150mm COVER IF LOCATED WITHIN PROPERTY.</li> <li>4. ALL PITS IN DRIVEWAYS TO BE 450x450 CONCRETE AND ALL PITS IN LANDSCAPED AREAS TO BE 450x450 PLASTIC.</li> </ul>	<ol> <li>ALL GR/</li> <li>ALL DR/</li> <li>ALL DR/</li> <li>ALL DR/</li> <li>ALL DR/</li> <li>ALL DR/</li> <li>ALL CALL EXI</li> <li>BUILDEI</li> <li>ALL WO</li> <li>INSPEC</li> <li>CONSTR</li> <li>CONSTR</li> <li>CONSTR</li> <li>CONCE IS</li> <li>ALL WO</li> <li>B.C.A. A</li> <li>REFER</li> <li>FOR LAI</li> </ol>
D	<ol> <li>5. PITS LESS THAN 600mm DEEP MAY BE BRICK, PRECAST OR CONCRETE.</li> <li>6. ALL BALCONIES AND ROOFS TO BE DRAINED AND TO HAVE SAFETY OVERFLOWS IN ACCORDANCE WITH RELEVANT AUSTRALIAN STANDARDS.</li> <li>7. ALL EXTERNAL SLABS TO BE WATERPROOFED.</li> </ol>	FOR LAI 16. CARE TO STRUCT PROTEC FROM N OSD BA
	Nuovo Design Studio	Banksto Council


PIPES NOTE:
Ø65 PVC @ MIN 1.0%
Ø90 PVC @ MIN 1.0%
Ø100 PVC @ MIN 1.0%
Ø150 PVC @ MIN 1.0%
Ø225 PVC @ MIN 0.5%
Ø300 PVC @ MIN 0.4%
UNLESS NOTED OTHERWISE


						Architect Nuovo Design Studio	<sup>Council</sup> Bankst
							Counc
В	ISSUE FOR DEVELOPMENT APPLICATION	19/12/2023	SFK	EH	OC		
А	ISSUE FOR DEVELOPMENT APPLICATION	01/12/2022	KTS	EH	OC	P: po box 5210 chullora postshop chullora	Client
Issue	Description	Date	Designed	Engineer	Checked	E: info@nuovodesignstudio.com.au W: www.nuovodesignstudio.com.au	Mr. S.
·10	1cm at full size				20cm	ř	





	NOTE: ALL PIPES ARE Ø100 PVC U.I	1.0.				
GRATES TO HAVE CHILD PROOF LOCKS.17. ALL PIPES IN BALCONIES TO BE Ø50mm HDPE ORDRAINAGE WORKS TO AVOID TREE ROOTS.PVC WRAPPED IN 20mm ABLEFLEX CAST IN SLABDPs TO HAVE LEAF GUARDS.AT MIN 1.0% SLOPE. CONTRACTOR TO PROVIDE AEXISTING LEVELS TO BE CONFIRMED BYBREAK / OPEN VOID IN RAIL / BALLUSTRADE FORDER PRIOR TO CONSTRUCTION.STORMWATER EMERGENCY OVERFLOW. ALLWORK WITHIN COUNCIL RESERVE TO BEENCLOSED AREAS/PLANTER BOXES TO BE'ECTED BY COUNCIL PRIOR TOFITTED WITH FLOOR WASTES & DRAINED TO OSDSTRUCTION.DOWNPIPES TO BE CHECKED BY ARCHITECT & .	NOTE: ALL GRATES WITHIN FOOTWAY AREAS TO BE HEEL GUARD & BIKE SAFE.		ER THAN 1.0m	OTE: EFER ARCHITI ET-OUT LEVEL	ECTURAL DRAWIN _S.	IGS FOR FINAL
NCIL'S ISSUED FOOTWAY DESIGN LEVELS TO NCORPORATED INTO THE FINISHED LEVELSPLUMBER PRIOR TO CONSTRUCTION8. THE OSD BASIN / TANK IS TO BE BUILT TO THE CORRECT LEVELS & SIZE AS PER THIS DESIGN.WORK SHALL BE IN ACCORDANCE WITHANY VARIATIONS ARE TO BE DONE UNDER CONSULTATION FROM OUR OFFICE ONLY. ANYA. AND A.S.3500.3.CONSULTATION FROM OUR OFFICE ONLY. ANYER TO LANDSCAPE ARCHITECT'S DRAWINGS LANDSCAPING.AMENDMENTS WITHOUT OUR APPROVAL WOULD RESULT IN ADDITIONAL FEES FOR REDESIGN AT OC STAGE OR IF A SOLUTION CANNOT BE FOUND, RECONSTRUCTION IS REQUIRED UNDER THE CONTRACTOR'S EXPENSES.	NOTE: IT IS CONTRACTOR'S RESP TO ENSURE MINIMUM PONI ACHIEVED OVER THE FLOO BY GRADING CATCHMENTS AT MINIMUM 1.0% FALL	DING IS R WASTES	NOTES: 1- CONTRACTOR IS TO EMERGENCY OVERFLO 2- DP/VD ARE Ø100mm 3- ALL TRANSFERRING 4- BALCONIES PIPES A ABLEFLEX CAST IN SLA	OW SPITTERS PIPES U.N.O. PIPES ARE S RE Ø50mm HE	TO ALL TRAPPED USPENDED U.N.O. DPE OR PVC WRAF	AREAS.
M NEW PITS, PIPES, RETAINING WALLS AND BASIN WATER LEVELS.					NOT FOR CONS	STRUCTION
SCALE 1:100 @ A1	F natta Road, Concord, NSW	ROPOSED E DEVE	STREET, PANANIA BOARDING HOUSE LOPMENT R CONCEPT PLAN		WATER CON ID LEVEL	CEPT PLAN
Metry Netry		-	ENT APPLICATION	Scale A1 1:100	Project No. 220601	Dwg. No. Issu 101 B

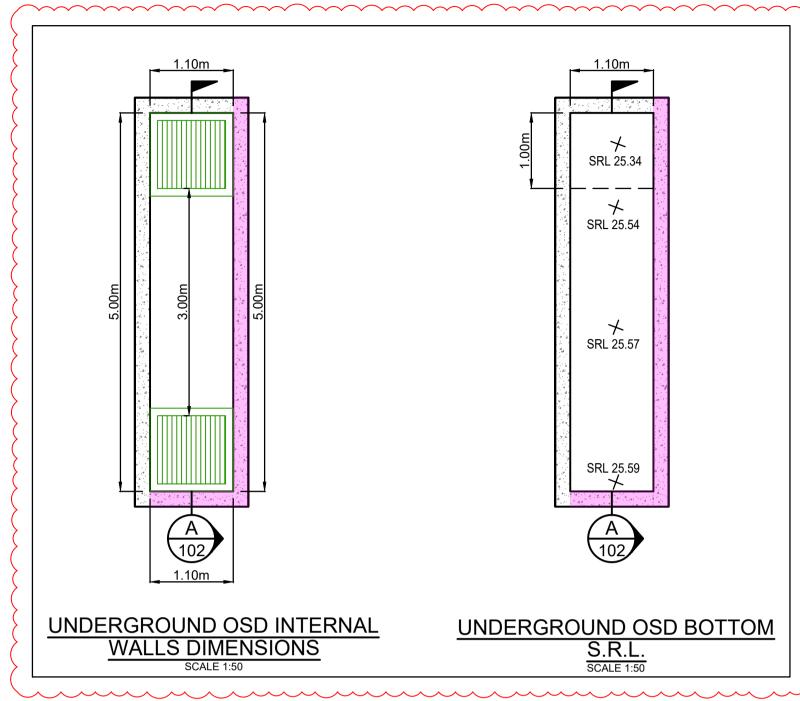


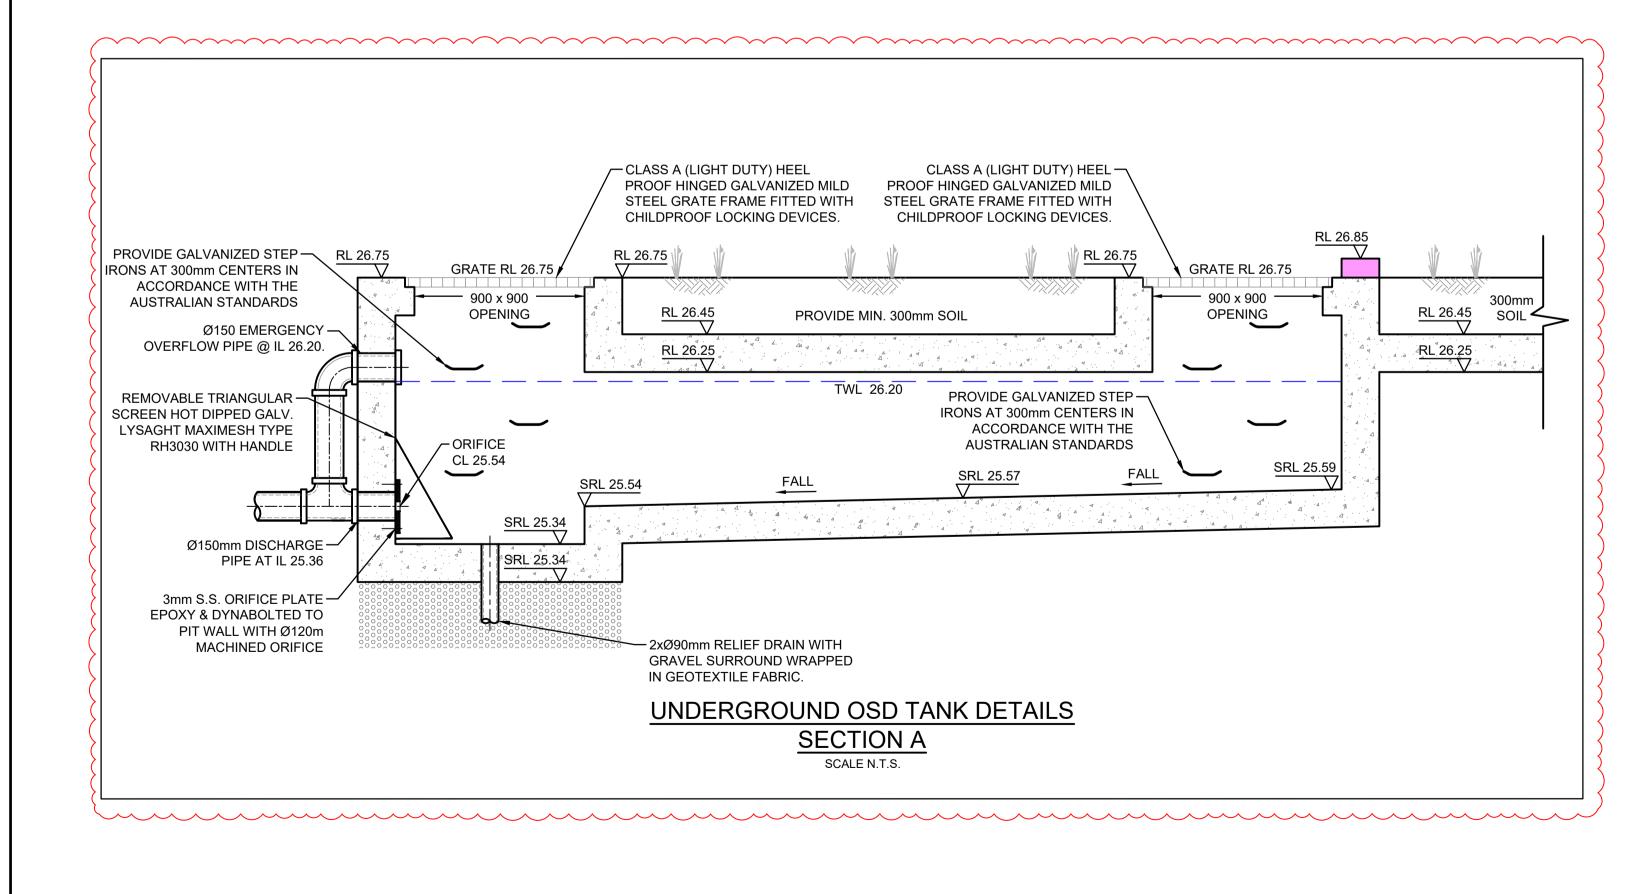


A       ISSUE FOR DEVELOPMENT APPLICATION       01/12/2022       KTS       EH       OC       P: po box 5210 chullora postshop chullora       Client       SCALE 1:50 @ A1       C       & 2137       STOF         Image: A strained Strain		10/12/2022 SEK		Nuovo Design Studio	Bankstown City Council	Scale 0 1 2 3 m	CIVIL & STORMWATER ENGINEERING SERVICES PTY LTD ABN: 27 644 422 506 Shop 1 142 147 Detromette Bood Concord NSW	Project 142 LAMB PROPOS C
1 0 1cm at full size 20cm DEV	A Issue		EH OC		<sup>Client</sup> Mr. S. Metry	SCALE 1:50 @ A1	C & S P:(02) 8397 6500	STORMW DEVELO

	Stormwa	ter Drainage System Main	tenance Schedule				
ESG220601							
Maintenance Action	Frequency	Responsibility	Procedure				
General							
Inspect roof drainage system of building and remove any debris/sludge	Six Monthly	Strata/Maintenance Contractor	Remove any leaves or debris and sludge from gutters of building and flush downpipes of building to remove any blockages. Pits downstream of downpipes to be cleaned of flushed debris.				
Inspect pits and trench drains on site and remove debris/litter/sludge	Monthly or following Rain Period	Strata/Maintenance Contractor	Remove grate. Remove any debris/litter/sludge from within pits.				
Inspect site for litter and floatable debris and remove	Fortnightly	Strata/Maintenance Contractor	Remove litter from site and sweep all driveway and pathways in order to remove leaves or sediments that may enter into the drainage system.				
Outlets							
Inspect grate for blockages	Six monthly	Owner	Remove any mulch or debris blocking grate.				
Inspect storage area to remove items that may cause blockage	Six monthly	Owner	Inspect storage area and remove all material which may float and be carried to grates.				
Inspect actual storage volume to design volume.	Annually	Maintenance Contractor	Calculate available volume and compare to volume on work as executed plan, if loss is greater than 5%, arrange for rectification and notify council of proposal.				
Inspect & remove any blockage of orifices	Six monthly	Strata/Maintenance Contractor	Remove grate & screen to inspect orifice. See plan for location of outlets				
Check attachment of orifice plates to wall of chamber and/or pit (gaps less than 5 mm)	Annually	Strata/Maintenance Contractor	Remove grate and screen. Ensure plates are mounted securely, tighten fixings if required. Seal gaps as required.				
Check orifice diameters are correct and retain sharp edges	Five yearly	Strata/Maintenance Contractor	Compare diameter to design (see Work-as-Executed) and ensure edge is not pitted or damaged.				
Inspect screen and clean	Six monthly	Strata/Maintenance Contractor	Remove grate(s) and screens if required to clean them.				
Check attachment of screens to wall of chamber or pit	Annually	Strata/Maintenance Contractor	Remove grate(s) and screen(s). Ensure screen fixings are secure. Repair as required.				
Check screen(s) for corrosion	Annually	Strata/Maintenance Contractor	Remove grate(s) and examine screen(s) for rust or corrosion, especially at corners or welds.				
Inspect grate(s) for damage or blockage	Six monthly	Strata/Maintenance Contractor	Check both sides of a grate for corrosion, (especially corners and welds) damage or blockage.				
Inspect outlet pipe & remove any blockage	Six monthly	Strata/Maintenance Contractor	Remove grate(s) and screen(s). Ventilate underground storage if present. Check orifices and remove any blockages in outlet pipe. Flush outlet pipe to confirm it drains freely. Check for sludge/debris on upstream side of return line.				
Check step irons for corrosion	Annually	Strata/Maintenance Contractor	Remove grate. Examine step irons and repair any corrosion or damage				
Check fixing of step irons is secure	Six monthly	Strata/Maintenance Contractor	Remove grate(s) and ensure fixings are secure prior to placing weight on step iron.				
Storage							
Inspect storage & remove any sediment/sludge in pit	Six monthly	Strata/Maintenance Contractor	Remove grate(s) and screen(s). Remove sediment/sludge build-up.				
Inspect internal walls of storage (and external, if appropriate) for cracks or spalling	Annually	Strata/Maintenance Contractor	Remove grate(s) to inspect internal walls. Repair as required. Clear vegetation from external walls if necessary and repair as required.				
Inspect & remove any debris/litter/mulch etc blocking grates	Six monthly	Strata/Maintenance Contractor	Remove blockages from grate(s) and check if storage is blocked.				
Inspect areas draining to the storage(s) & remove debris/mulch/litter etc likely to block screens/grates	Six monthly	Strata/Maintenance Contractor	Remove debris and floatable material likely to be carried to grates.				
Compare storage volume to volume approved. (Rectify if $loss > 5\%$ )	Annually	Strata/Maintenance Contractor	Compare actual storage available with Work-as Executed plans. If volume loss is greater than 5%, arrange for reconstruction to replace the volume lost. Council to be notified of the proposal.				
Inspect storages for subsidence near pits	Annually	Strata/Maintenance Contractor	Check along drainage lines and at pits for subsidence likely to indicate leakages.				

DRAINS RESULTS						
STORM EVENT (ARI)	PRE-DEV INTERNAL FLOWS (L/s)				WATER STORAGE LEVEL (m)	
5YR	16	14	2	12	25.69	
10YR	18	16	2	18	25.74	
20YR	21	18	3	21	25.81	
50YR	23	19	3	22	25.86	
100YR	25	20	3	23	25.97	

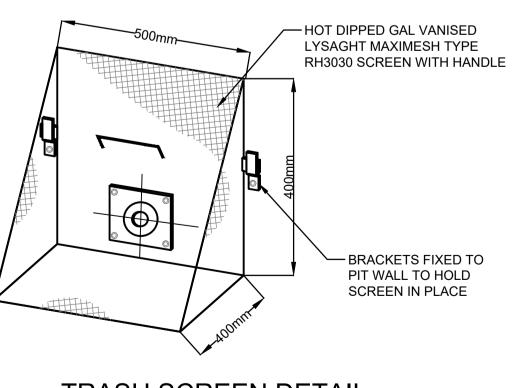

TRASH SCREEN DETAIL

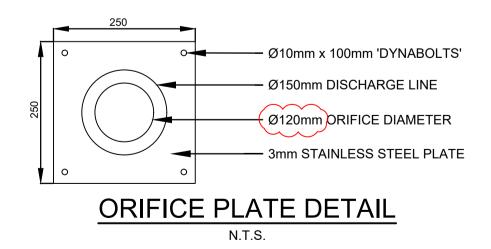

BETH STREET, PANANIA	
SED BOARDING HOUSE	
DEVELOPMENT	
WATER CONCEPT PLAN	
OPMENT APPLICATION	


## NOT FOR CONSTRUCTION
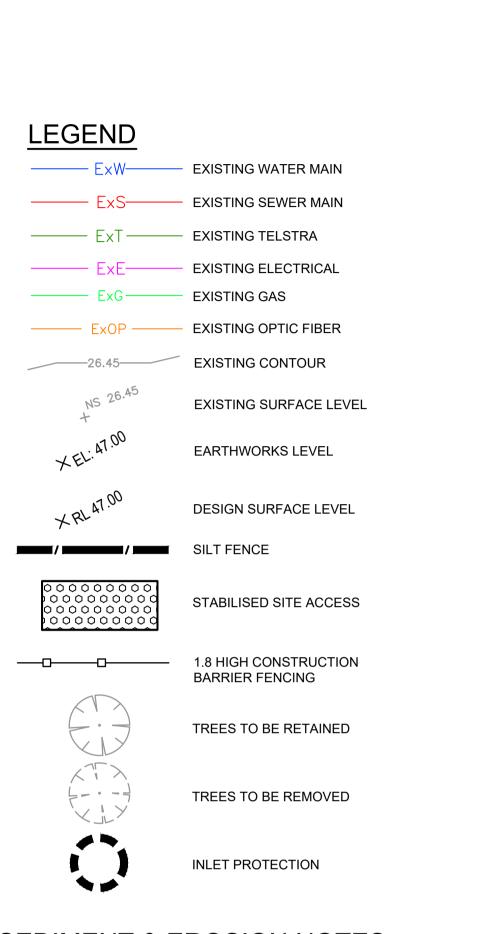
## ON-SITE DETENTION DETAILS AND CALCULATION SHEET

Scale A1 Pr As Shown

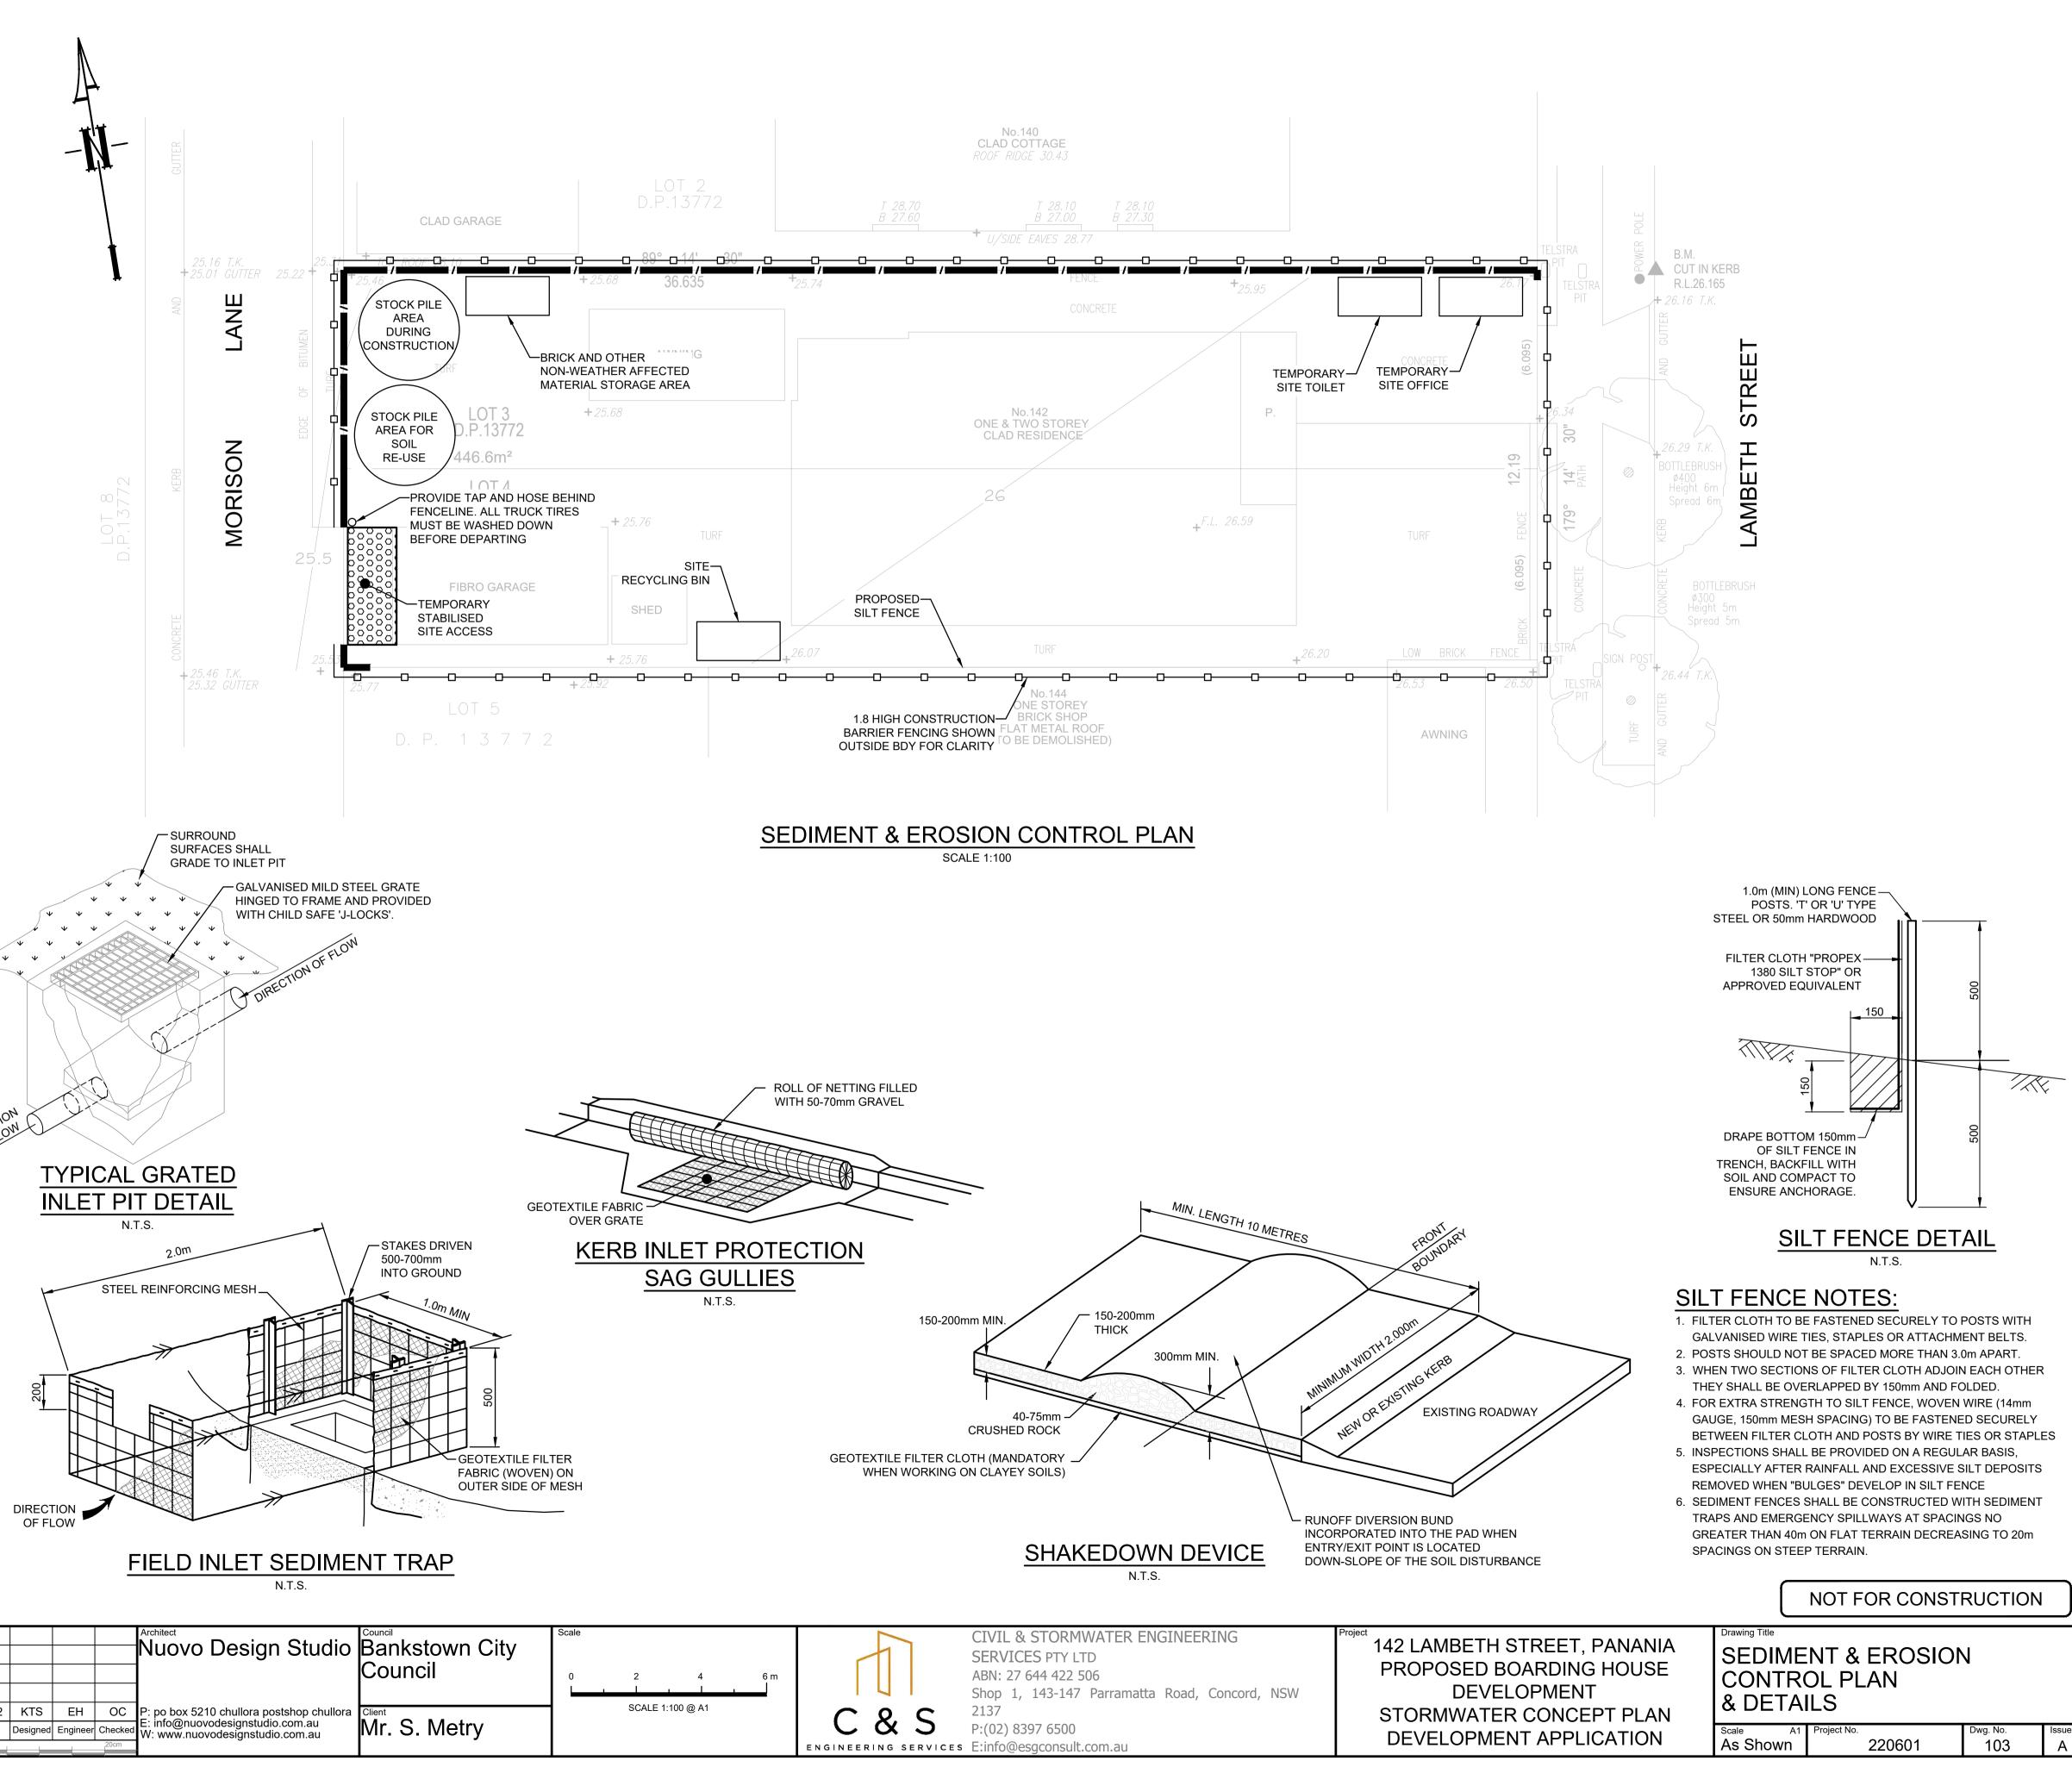
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## **SEDIMENT & EROSION NOTES**

- IMMEDIATELY FOLLOWING SETTING OUT OF THE WORKS, BUT PRIOR TO COMMENCEMENT OF ANY CLEARING OR EARTHWORKS, THE CONTRACTOR AND SUPERINTENDENT SHALL WALK THE SITE TO NOMINATE THE LOCATIONS AND TYPES OF SEDIMENT AND EROSION CONTROL MEASURES TO BE ADOPTED. THESE MEASURES SHALL BE IMPLEMENTED PRIOR TO ANY CLEARING OR EARTHWORKS AND MAINTAINED UNTIL THE WORKS ARE COMPLETED AND NO LONGER POSE AN EROSION HAZARD. UNLESS OTHERWISE APPROVED BY THE SUPERINTENDENT.
- 2. IMMEDIATELY FOLLOWING SETTING OUT OF THE WORKS, BUT PRIOR TO COMMENCEMENT OF ANY CLEARING OR EARTHWORKS, THE CONTRACTOR AND SUPERINTENDENT SHALL WALK THE SITE TO IDENTIFY AND MARK TREES WHICH ARE TO BE PRESERVED. NOTWITHSTANDING THE ABOVE, THE CONTRACTOR SHALL TAKE ALL REASONABLE PRECAUTIONS TO MINIMISE DISTURBANCE TO EXISTING VEGETATION AND GROUND COVER OUTSIDE THE MINIMUM AREAS REQUIRED TO COMPLETE THE WORKS AND SHALL BE RESPONSIBLE FOR RECTIFICATION, AT ITS OWN COST, OF ANY DISTURBANCE BEYOND THOSE AREAS.
- 3. PROVIDE GULLY GRATE INLET SEDIMENT TRAPS AT ALL GULLY PITS. 4. PROVIDE SILT FENCING ALONG PROPERTY LINE AS DIRECTED BY SUPERINTENDENT.
- 5. ADDITIONAL CONTROL DEVICES TO BE PLACED WHERE DIRECTED BY THE PRINCIPLE
- 6. ALTERNATIVE DESIGNS TO BE APPROVED BY SUPERINTENDENT PRIOR TO CONSTRUCTION.
- 7. WASH DOWN/RUMBLE AREA TO BE CONSTRUCTED WITH PROVISIONS RESTRICTING ALL SILT AND TRAFFICKED DEBRIS FROM ENTERING THE STORMWATER SYSTEM.
- 8. NO WORK OR STOCKPILING OF MATERIALS TO BE PLACED OUTSIDE OF SITE WORK BOUNDARY
- 9. APPROPRIATE EROSION AND SEDIMENT CONTROLS TO BE USED TO PROTECT STOCKPILES AND MAINTAINED THROUGH OUT CONSTRUCTION. 10. IT IS THE CONTRACTORS RESPONSIBILITY TO TAKE DUE CARE OF NATURAL
- VEGETATION. NO CLEARING IS TO BE UNDERTAKEN WITHOUT PRIOR APPROVAL FROM THE SUPERINTENDENT.
- 11. TO AVOID DISTURBANCE TO EXISTING TREES, EARTHWORKS WILL BE MODIFIED AS DIRECTED ON-SITE BY THE SUPERINTENDENT.
- 12. THE LOCATION OF EROSION AND SEDIMENTATION CONTROLS WILL BE DETERMINED ON SITE BY THE SUPERINTENDENT.
- 13. ACCESS TRACKS THROUGH THE SITE WILL BE LIMITED TO THOSE DETERMINED BY THE SUPERINTENDENT AND THE CONTRACTOR PRIOR TO ANY WORK COMMENCING.
- 14. ALL SETTING OUT IS THE RESPONSIBILITY OF THE CONTRACTOR PRIOR TO WORKS COMMENCING ON SITE. THE SUPERINTENDENT'S SURVEYOR SHALL PEG ALL ALLOTMENT BOUNDARIES, PROVIDE COORDINATE INFORMATION TO THESE PEGS AND PLACE BENCH MARKS. THE CONTRACTOR SHALL SET OUT THE WORKS FROM AND MAINTAIN THESE PEGS.



						Nuovo Design Studio	Banks
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